


KEY MAP

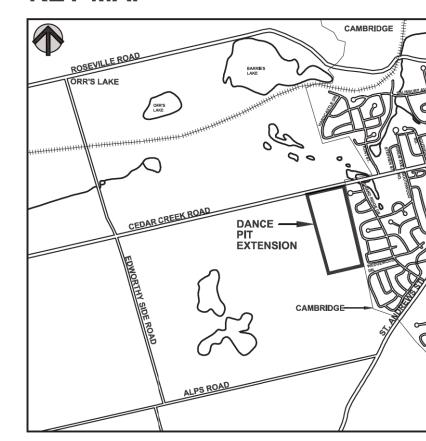

EXISTING FEATURES NOTES

GENERAL SITE PLAN INFORMATION

- 1. THIS SITE PLAN CONSISTS OF 5 DRAWINGS AND MUST BE READ COLLECTIVELY.
- 2. ALL MEASUREMENTS SHOWN ON THIS SITE PLAN ARE IN METRES.

LICENCE INFORMATION

- 3. THIS SITE PLAN IS PREPARED FOR SUBMISSION TO THE MINISTRY OF NATURAL RESOURCES AND AN FORESTRY UNDER THE AGGREGATE RESOURCES ACT FOR A CLASS 'A' LICENCE, PIT ABOVE THE WATER TABLE.
- 4. APPLICANT: ST. MARYS CEMENT INC. (CANADA) **55 INDUSTRIAL STREET**
- TORONTO, ON, M4G 3W9 5. TOTAL AREA TO BE LICENCED:

TOTAL AREA TO BE EXTRACTED: TOTAL AREA TO BE REHABILITATED:

BASE INFORMATION

- 6. TOPOGRAPHIC INFORMATION WAS OBTAINED FROM EXISTING FEATURES PLAN (SHEET 1 OF 3) OF CEDAR STREET PIT BY PLANNING INITIATIVES LTD. DATED OCTOBER 1991 AND FIRST BASE **SOLUTIONS, JANUARY 1, 2017.**
- THE SITE WAS FIELD CHECKED BY HARRINGTON McAVAN LTD., MAY 2, 2016. 7. ZONING INFORMATION OBTAINED FROM THE CITY OF CAMBRIDGE SCHEDULE "A" TO
- ZONING BY-LAW NUMBER 150-13, MAP 1, DATED AUGUST 12, 2013 AND THE TOWNSHIP OF NORTH DUMFRIES, ZONING MAP - NORTH CENTRAL TOWNSHIP, JULY 2019.

HYDROGEOLOGICAL INFORMATION

- 8. HYDROGEOLOGICAL INFORMATION INCLUDING GROUNDWATER ELEVATION WAS OBTAINED FROM REPORT BY GOLDER ASSOCIATES LTD., DATED APRIL 2021.
- 9. THE WATER TABLE ELEVATION SLOPES ACROSS SITE AND RANGES BETWEEN 307.2 309.3m ABOVE SEA (M.A.S.L.) BASED ON THE HYDROGEOLOGICAL REPORT (SEE ABOVE).

- 10. HYDROGEOLOGICAL INFORMATION WAS OBTAINED FROM REPORT BY GOLDER ASSOCIATES LTD. DATED APRIL 2021 (REFER TO SHEET 3 OF 5 FOR TECHNICAL RECOMMENDATIONS).
- 11. NATURAL ENVIRONMENT INFORMATION WAS OBTAINED FROM REPORT BY GOLDER ASSOCIATES LTD. DATED APRIL 2021 (REFER TO SHEET 3 OF 5 FOR TECHNICAL RECOMMENDATIONS).
- DATED SEPTEMBER 2017 (REFER TO SHEET 3 OF 5 FOR TECHNICAL RECOMMENDATIONS).
- 13. AIR QUALITY ASSESSMENT INFORMATION WAS OBTAINED FROM REPORT BY GOLDER ASSOCIATES LTD. DATED DECEMBER 2019 (REFER TO SHEET 3 OF 5 FOR TECHNICAL RECOMMENDATIONS).
- 14. ACOUSTICAL INFORMATION WAS OBTAINED FROM NOISE REPORT BY GOLDER ASSOCIATES LTD. DATED MARCH 2021 (REFER TO SHEET 3 OF 5 FOR TECHNICAL RECOMMENDATIONS).

LEGEND

		120m INFORM	MATION BOUNDARY				
	and the second s	BOUNDARY	OF AREA TO BE LICENSED				
		BOUNDARY	OF EXISTING LICENCE				
		REGULATORY SETBACK LINE					
		LIMIT OF EXTRACTION LINE					
		LOT/ CONCESSION LINE					
		PROPERTY L	INE				
x —— x ——	EXISTING FENCE	• HP	EXISTING HYDRO POLE				
310	EXISTING 1m CONTOUR LINE	<	DIRECTION OF SURFACE WATER DRAINAGE				
_ <u>31</u> 1	EXISTING 1m CONTOUR LINE	▲ BH/	BOREHOLE LOCATION AND				
· · · · · · · · · · · · · · · · · · ·	EXISTING VEGETATION	₩ MW	NUMBER DRILLED AND MONITORING WELLS INSTALLED BY GOLDER ASSOCIATES LTD.				
	EXISTING BERM	r ia	JANUARY 2016				
m	EXISTING EXTRACTION FACE	₽ TP	TEST PIT LOCATION AND NUMBER DUG BY APPLICANT JANUARY 2016				
	EXISTING STOCKPILE	A	LOCATION OF SECTION				
	EXISTING WETLAND	1	EXISTING BUILDING AND NUMBER				
-	EXISTING FIELD ENTRANCE/EXIT						
	EXISTING PIT ENTRANCE/EXIT						

BUILDING LIST

28.4 ha

21.2 ha

21.2 ha

No.	
1.	ONE STORY HOUSES
2.	TWO STORY HOUSES
3.	SHED
4.	BARN
	·

ΝО,	DATE	REVISIONS	OWNER	НМ	Мик	J	ŅО,	DATE	REVISIONS	OWNER	HM	M
\10	DATE	DE 4CIO/IC	OWNED	нМ	MAID	1	NO	DATE	DE actoric	ONNED	нМ	М
1	0CT 2022	PER MNRF COMMENTS										
2	JUNE 2023	PER MNRF COMMENTS										

Pre Licence Review

Site Plan Amendments



Project Name



St. Marys Cement Inc. (Canada) 55 Industrial Street Toronto, Ontario M4G 3W9 (416) 423-1300

DANCE PIT EXTENSION

LICENSEE SIGNATURE LICENCE No. PART LOT 14 &15, CONCESSION 10 TOWNSHIP OF NORTH DUMFRIES, REGIONAL MUNICIPALITY OF WATERLOO

Scale 1:2000 **Drawing Status ISSUED FOR APPROVAL**

S.B./ A.C.


Checked G.D.H./R.M.

Issue Date JUNE 2023 **Project Number**

12-10

Drawing Number

Drawing Title EXISTING FEATURES PLAN

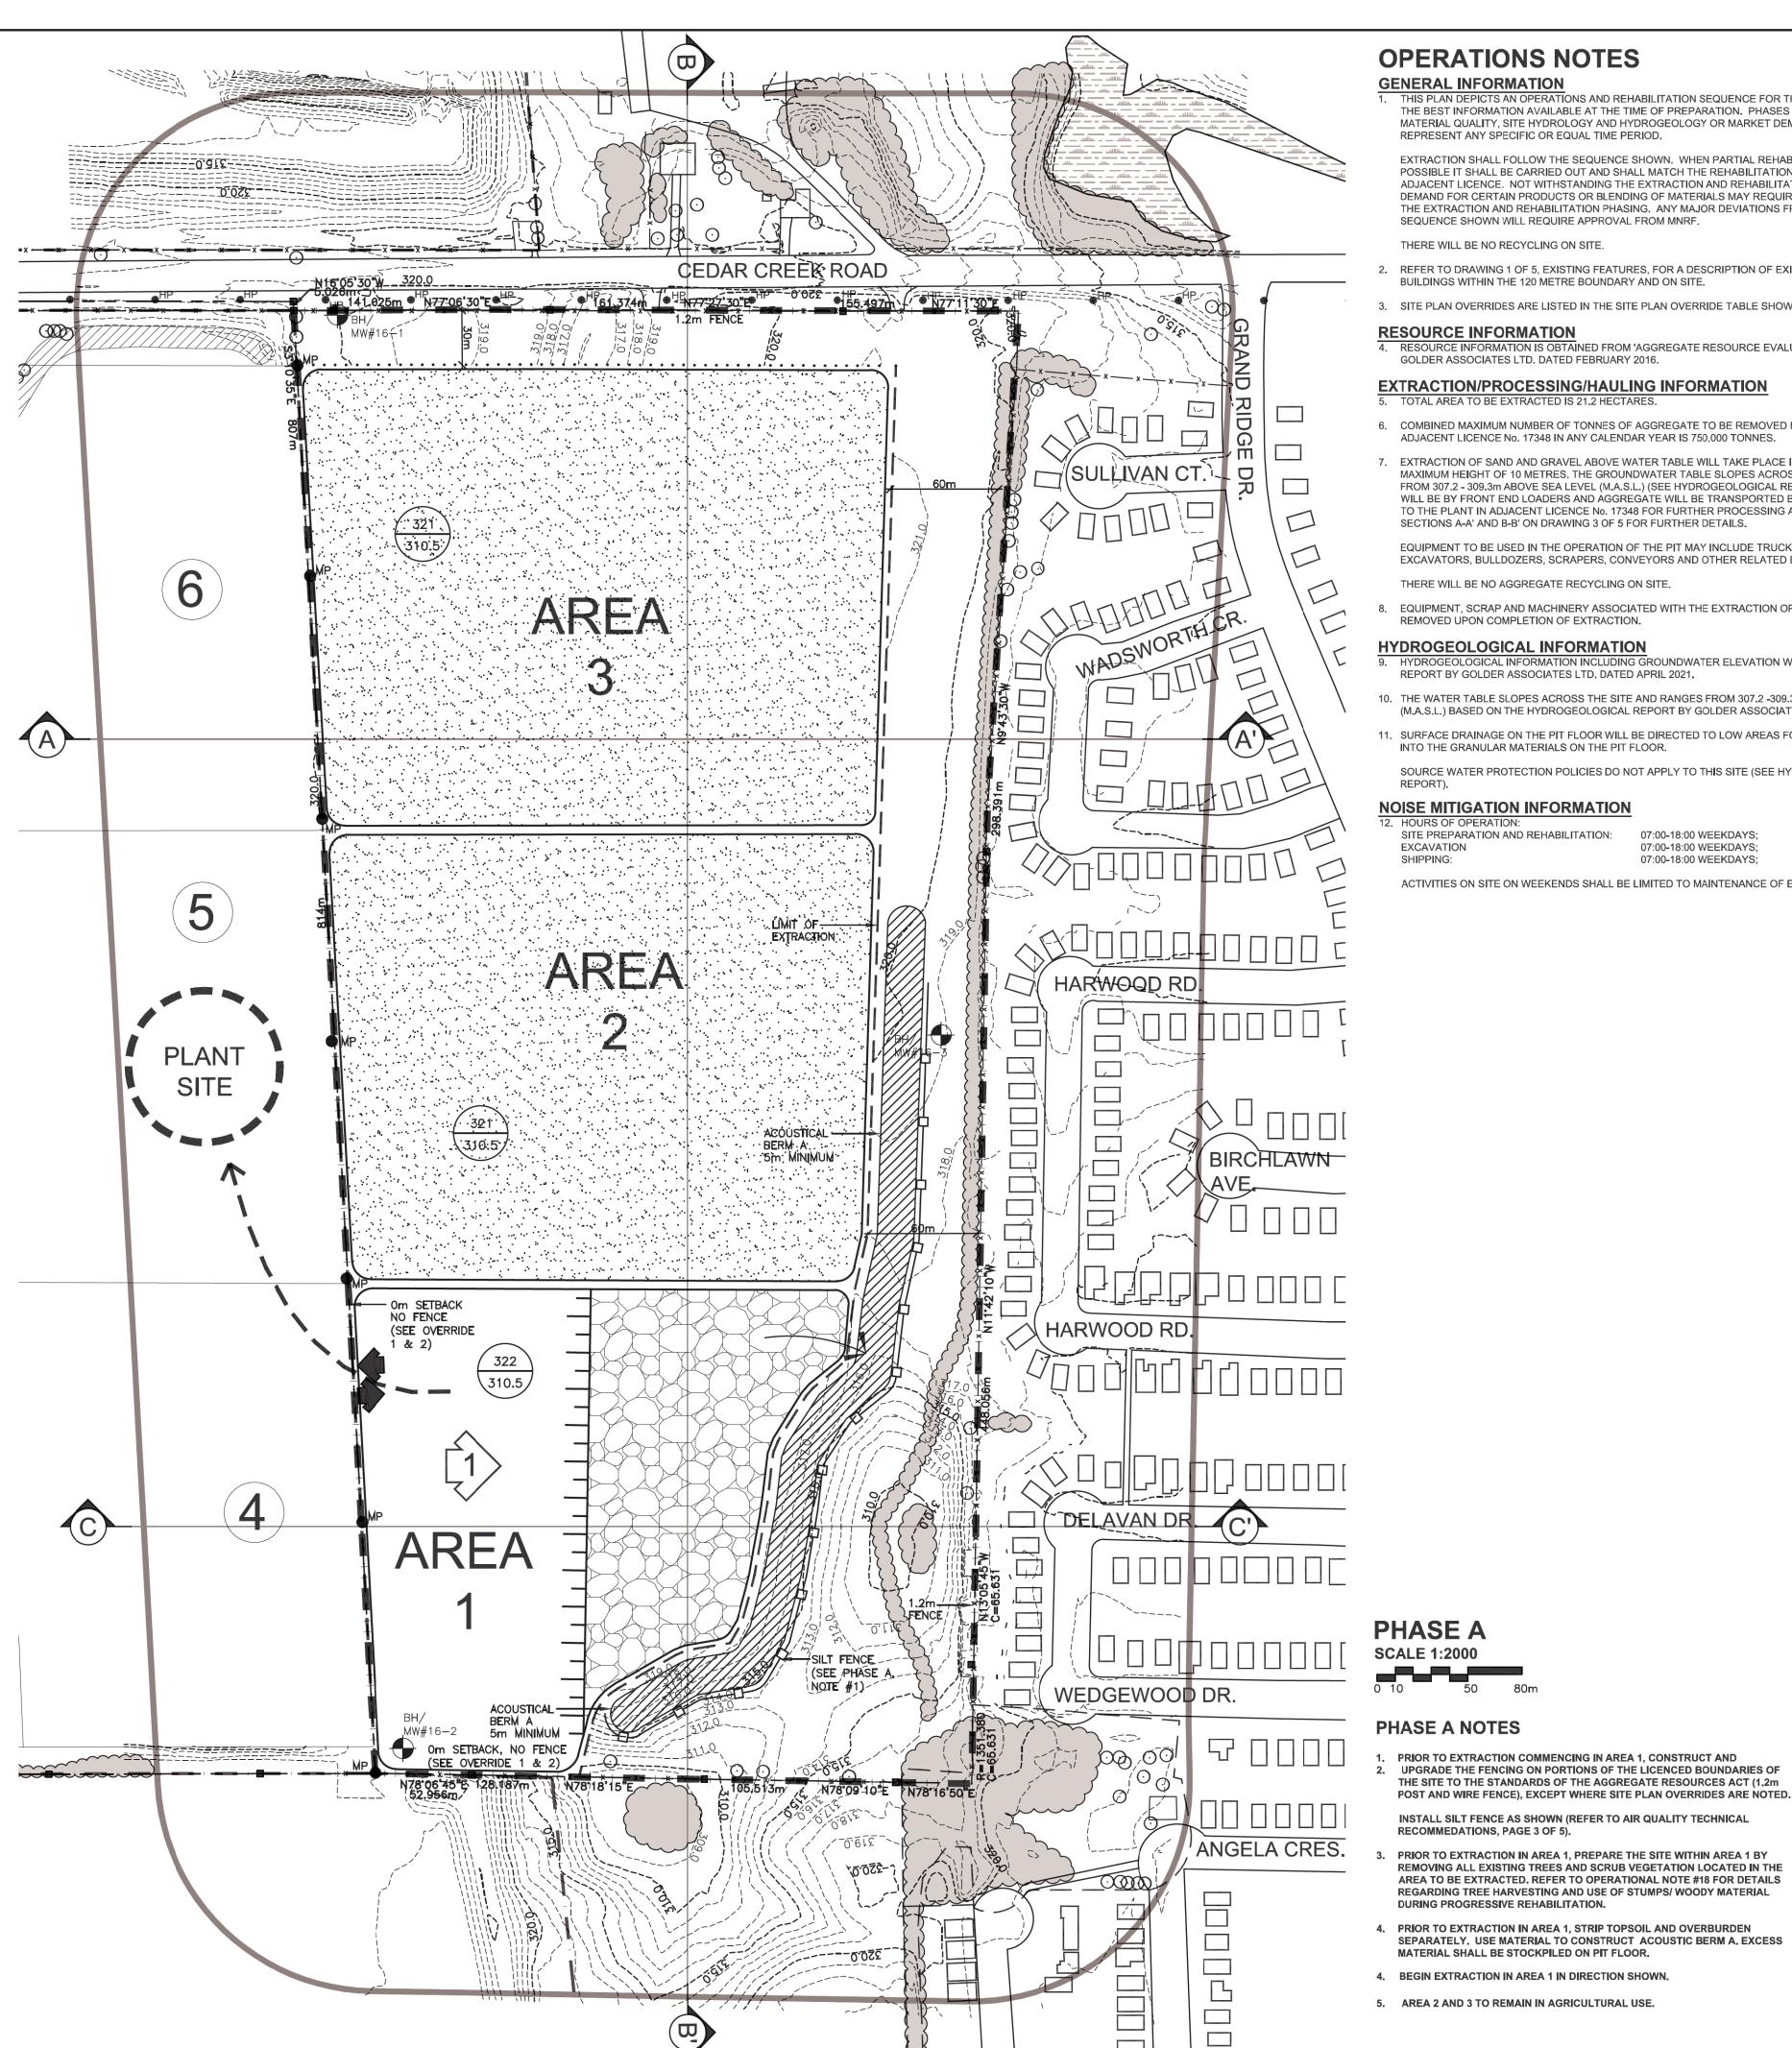

OPERATIONS NOTES

THIS PLAN DEPICTS AN OPERATIONS AND REHABILITATION SEQUENCE FOR THIS PROPERTY BASED ON THE BEST INFORMATION AVAILABLE AT THE TIME OF PREPARATION. PHASES SHOWN MAY VARY WITH MATERIAL QUALITY, SITE HYDROLOGY AND HYDROGEOLOGY OR MARKET DEMAND. PHASES DO NOT REPRESENT ANY SPECIFIC OR EQUAL TIME PERIOD.

EXTRACTION SHALL FOLLOW THE SEQUENCE SHOWN. WHEN PARTIAL REHABILITATION OF A PHASE IS POSSIBLE IT SHALL BE CARRIED OUT AND SHALL MATCH THE REHABILITATION GRADES OF THE ADJACENT LICENCE. NOT WITHSTANDING THE EXTRACTION AND REHABILITATION PROCESS ABOVE DEMAND FOR CERTAIN PRODUCTS OR BLENDING OF MATERIALS MAY REQUIRE SOME DEVIATION IN THE EXTRACTION AND REHABILITATION PHASING. ANY MAJOR DEVIATIONS FROM THE OPERATIONS SEQUENCE SHOWN WILL REQUIRE APPROVAL FROM MNRF.

THERE WILL BE NO RECYCLING ON SITE.

- 2. REFER TO DRAWING 1 OF 5, EXISTING FEATURES, FOR A DESCRIPTION OF EXISTING VEGETATION AND BUILDINGS WITHIN THE 120 METRE BOUNDARY AND ON SITE.
- 3. SITE PLAN OVERRIDES ARE LISTED IN THE SITE PLAN OVERRIDE TABLE SHOWN ON THIS PAGE.

RESOURCE INFORMATION

RESOURCE INFORMATION IS OBTAINED FROM 'AGGREGATE RESOURCE EVALUATION' REPORT BY GOLDER ASSOCIATES LTD. DATED FEBRUARY 2016.

EXTRACTION/PROCESSING/HAULING INFORMATION TOTAL AREA TO BE EXTRACTED IS 21.2 HECTARES

- 6. COMBINED MAXIMUM NUMBER OF TONNES OF AGGREGATE TO BE REMOVED FROM THIS SITE AND ADJACENT LICENCE No. 17348 IN ANY CALENDAR YEAR IS 750,000 TONNES.
- EXTRACTION OF SAND AND GRAVEL ABOVE WATER TABLE WILL TAKE PLACE IN ONE BENCH, WITH A MAXIMUM HEIGHT OF 10 METRES. THE GROUNDWATER TABLE SLOPES ACROSS THE SITE AND RAGES FROM 307.2 - 309.3m ABOVE SEA LEVEL (M.A.S.L.) (SEE HYDROGEOLOGICAL REPORT). EXTRACTION WILL BE BY FRONT END LOADERS AND AGGREGATE WILL BE TRANSPORTED BY TRUCK OR CONVEYOR TO THE PLANT IN ADJACENT LICENCE No. 17348 FOR FURTHER PROCESSING AND SHIPPING. REFER TO SECTIONS A-A' AND B-B' ON DRAWING 3 OF 5 FOR FURTHER DETAILS.

EQUIPMENT TO BE USED IN THE OPERATION OF THE PIT MAY INCLUDE TRUCKS, LOADERS, EXCAVATORS, BULLDOZERS, SCRAPERS, CONVEYORS AND OTHER RELATED EQUIPMENT.

EQUIPMENT, SCRAP AND MACHINERY ASSOCIATED WITH THE EXTRACTION OPERATIONS WILL BE REMOVED UPON COMPLETION OF EXTRACTION.

HYDROGEOLOGICAL INFORMATION

HYDROGEOLOGICAL INFORMATION INCLUDING GROUNDWATER ELEVATION WAS OBTAINED FROM REPORT BY GOLDER ASSOCIATES LTD, DATED APRIL 2021.

- 10. THE WATER TABLE SLOPES ACROSS THE SITE AND RANGES FROM 307.2 -309.3m ABOVE SEA LEVEL (M.A.S.L.) BASED ON THE HYDROGEOLOGICAL REPORT BY GOLDER ASSOCIATES, DATED APRIL 2021.
- 11. SURFACE DRAINAGE ON THE PIT FLOOR WILL BE DIRECTED TO LOW AREAS FOR WATER TO INFILTRATE INTO THE GRANULAR MATERIALS ON THE PIT FLOOR.

SOURCE WATER PROTECTION POLICIES DO NOT APPLY TO THIS SITE (SEE HYDROGEOLOGICAL

NOISE MITIGATION INFORMATION

SITE PREPARATION AND REHABILITATION: 07:00-18:00 WEEKDAYS; EXCAVATION

07:00-18:00 WEEKDAYS; 07:00-18:00 WEEKDAYS:

ACTIVITIES ON SITE ON WEEKENDS SHALL BE LIMITED TO MAINTENANCE OF EQUIPMENT ONLY.

AIR QUALITY INFORMATION

WATER OR CALCIUM CHLORIDE WILL BE APPLIED TO INTERNAL HAUL ROADS AND PROCESSING AREAS AS OFTEN AS REQUIRED TO MITIGATE DUST.

SITE MANAGEMENT INFORMATION

MAINTENANCE/ PROTECTION OF VEGETATION INFORMATION

EXISTING VEGETATION WITHIN THE LICENCED AREA SHALL BE MAINTAINED IN A HEALTHY VIGOROUS GROWING CONDITION UNTIL SEQUENTIAL STRIPPING BEGINS OR UNTIL THE REHABILITATION IS COMPLETE. ANY VEGETATION PLANTED AS PART OF SITE IMPROVEMENTS OR PROGRESSIVE AND FINAL REHABILITATION WILL ALSO BE MAINTAINED IN A HEALTHY, VIGOROUS GROWING CONDITION.

- 5. BOUNDARIES OF THE AREA TO BE LICENCED THAT ARE PRESENTLY FENCED ARE SHOWN ON DRAWING 1 OF 5 EXISTING FEATURES. PRIOR TO ANY STRIPPING OR PREPARATION, FENCING ON THE LICENCED BOUNDARIES WILL BE UPGRADED TO 1.2m HIGH POST AND WIRE FENCE TO COMPLY WITH THE AGGREGATE RESOURCES ACT WHERE REQUIRED (EXCEPT WHERE SITE PLAN OVERRIDES ARE NOTED). HIGHLY VISIBLE AND SEPARATELY DISTINGUISHABLE 1.2m HIGH PAINTED MARKER POSTS WILL BE INSTALLED ALONG THE THE WEST SHARED BOUNDARY.
- SILT FENCE SHALL BE INSTALLED AT THE OUTSIDE TOE OF ALL BERMS AS THEY ARE CONSTRUCTED. ALL FENCING AND MARKER POSTS SHALL BE MAINTAINED.

TOPSOIL AND OVERBURDEN SHALL BE STRIPPED AND STORED SEPARATELY IN BERMS AND STOCKPILES, AS SHOWN. SOIL STRIPPING/HANDLING WILL ONLY OCCUR DURING DRY (UNSATURATED) AND UNFROZEN CONDITIONS, TOPSOIL BERMS SHALL BE GRADED TO STABLE SLOPES AND SEEDED WITH A GRASS/LEGUME MIXTURE TO PREVENT EROSION AND MINIMIZE DUST. IF TOPSOIL IS STORED IN STOCKPILES FOR PROLONGED PERIODS, EROSION CONTROL MEASURES WILL BE ESTABLISHED, PRIOR O THE COMMENCEMENT OF STRIPPING, BASELINE SOIL SAMPLING WILL BE UNDERTAKEN TO DOCUMENT KEY AGRICULTURAL SOIL CHARACTERISTICS (E.G., MACRO AND MICRONUTRIENTS, PH, CEC, ORGANIC MATTER, SOIL TEXTURE, STRUCTURE, AND BULK DENSITY ETC.), USING AN ACCREDITED LAB FOR ANALYTICAL TESTING.

BERM INFORMATION

7. BERMS SHALL CREATE AN ACOUSTICAL BARRIER PER TECHNICAL RECOMMENDATIONS. BERMS SHALL NOT EXCEED 2:1, REFER TO TYPICAL BERM CROSS SECTION ON DRAWING 4 OF 5 DETAILS AND SECTIONS. ALL BERMS SHALL BE SEEDED (USING GRASS/ LEGUME MIXTURE, SEE REHABILITATION PLAN, NOTE #7) IMMEDIATELY UPON COMPLETION,

ON COMPLETION OF THE BERMS, EXCESS ON-SITE OVERBURDEN WILL BE USED TO PROGRESSIVELY BACKFILL AND REHABILITATE THE SITE.

ALL SCRAP AND USED MACHINERY GENERATED THROUGH THE OPERATIONS WITHIN THIS LICENCE WILL BE REMOVED ON AN ONGOING BASIS, LOGS WILL BE UTILIZED FOR FIREWOOD OR THEIR BEST USE. STUMPS, LOGS, AND OVERSIZE ROCKS MAY REMAIN ON SITE FOR USE IN PROGRESSIVE REHABILITATION, STUMPS WILL BE GROUND AND OVERSIZE ROCKS SHALL BE USED TO CONSTRUCT THE BASE OF SIDE SLOPES. UPON COMPLETION OF EXTRACTION, ALL SCRAP EQUIPMENT AND USED MACHINERY SHALL BE REMOVED.

LEGEND

120m INFORMATION BOUNDARY **BOUNDARY OF AREA TO BE LICENSED BOUNDARY OF EXISTING LICENCE**

LIMIT OF EXTRACTION LINE REGULATORY SETBACK LINE

EXISTING VEGETATION BERM (MIN, HEIGHT AS SHOWN)

UNDISTURBED AREA

AND OVERBURDEN

EXTRACTION FACE

EXISTING WETLAND

AREA STRIPPED OF TOPSOIL

EXISTING HYDRO POLE DIRECTION OF TOPSOIL AND

OVERBURDEN MOVEMENT DIRECTION OF EXTRACTION

EXISTING BUILDING

BOREHOLE LOCATION AND NUMBER DRILLED AND MONITORING WELLS INSTALLED BY GOLDER ASSOCIATES LTD.

PRODUCT TRANSPORTATION


EXISTING ENTRANCE/ EXIT (LOCATION IS APPROXIMATE) **LOCATION OF SECTION**

JANUARY 2016

SITE PLAN OVERRIDE (VARIANCE)

THE FOLLOWING CONDITIONS ILLUSTRATED ON THESE PLANS VARY FROM THE OF THE PROVINCIAL

STANDARDS MADE UNDER THE AGGREGATE RESOURCES ACT FENCING IS OMITTED ALONG THE ENTIRE WEST BOUNDARY, ADJACENT LICENSED LANDS UNDER SAME LICENSEE, AND ALONG THE SOUTH BOUNDARY PER AGREEMENT WITH ADJACENT LICENSEE/LANDOWNER. SETBACK IS REDUCED TO 0m ALONG WEST BOUNDARY, ADJACENT LICENSED LANDS 0.13(1)10i UNDER SAME LICENSEE AND ALONG THE SOUTH BOUNDARY PER AGREEMENT WITH ADJACENT LICENSEE/LANDOWNER. GATE OMITTED BETWEEN THE SITE AND ADJACENT LICENCE. ADJACENT LICENSED LANDS | 0.13(1)1 UNDER THE SAME LICENSEE STOCKPILES MAY BE LOCATED WITHIN 30m OF THE WEST BOUNDARY, ADJACENT PIT IS 0.13(1)13i SAME LICENSEE.

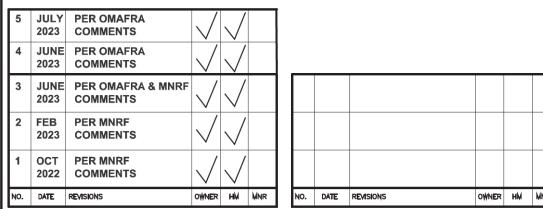

Pre Licence Review

Site Plan Amendments



Project Name



St. Marys Cement Inc. (Canada) **55 Industrial Street** Toronto, Ontario M4G 3W9 (416) 423-1300

DANCE PIT EXTENSION

LICENSEE SIGNATURE LICENCE No. PART LOT 14 &15, CONCESSION 10 TOWNSHIP OF NORTH DUMFRIES, REGIONAL MUNICIPALITY OF WATERLOO

Scale 1:2000 **Drawing Status ISSUED** FOR APPROVAL


Issue Date JULY 2023

Checked G.D.H./R.M A.C./S.B. Drawing Title

Project Number 12-10

OPERATIONAL PLAN PHASE A

Drawing Number

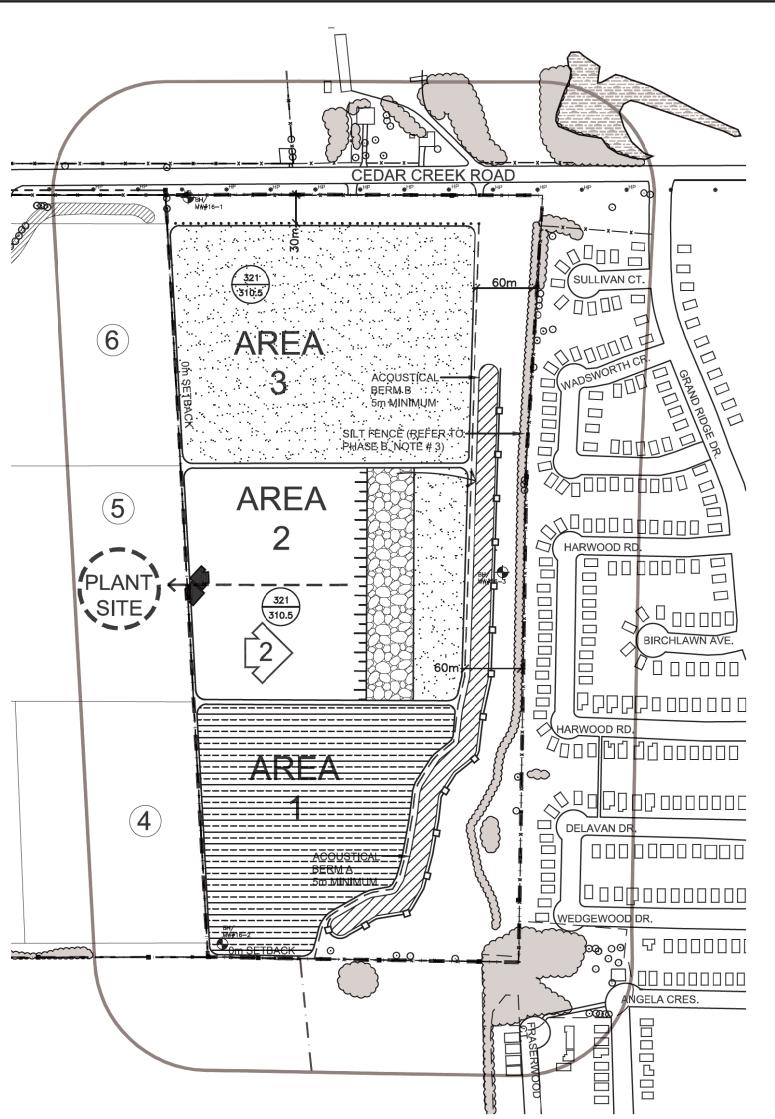

PHASE B

- PHASE B NOTES
- 1. COMPLETE EXTRACTION IN AREA 1.
- 2. PREPARE SITE WITHIN AREA 2 BY REMOVING ALL EXISTING TREES AND SCRUB VEGETATION LOCATED IN THE AREA TO BE EXTRACTED.
- 3. BEGIN STRIPPING TOPSOIL AND OVERBURDEN SEPARATELY FROM AREA 2 AND USE THE MATERIAL TO CONSTRUCT ACOUSTIC BERM B (EXTENSION OF BERM A) AS SHOWN, EXCESS MATERIAL, IF AVAILABLE, SHALL BE USED TO BEGIN PROGRESSIVE REHABILITATION OF AREA 1, INSTALL SILT FENCE AS SHOWN (SEE AIR QUALITY TECHNICAL RECOMMENDATIONS, THIS PAGE).
- 4. BEGIN EXTRACTION IN AREA 2, IN DIRECTION SHOWN.
- 5. AREA 3 TO REMAIN IN AGRICULTURAL USE.

PHASE C PHASE C NOTES

1. CONTINUE REHABILITATION OF AREA 1 USING TOPSOIL AND OVERBURDEN NOT REQUIRED FOR ACOUSTIC BERM **CONSTRUCTION AND COMPLETE EXTRACTION IN AREA 2.**

ACOUSTIC-

₹3m MINIMUM (REFER TO

BERM D

LICENCE

SILT FENCE -

NOTE 4)

SULLIVAN CT

HARWOOD RI

XHARWOOD RD

DELAVAN DR.

WEDGEWOOD DR.

PHASE D (NOT SHOWN)

1. COMPLETE EXTRACTION IN AREA 3.

3. RETURN SITE TO AGRICULTURE.

2. COMPLETE REHABILITATION OF ALL AREAS

(INCLUDING HAUL ROADS) USING TOPSOIL AND

OVERBURDEN STORED IN ACOUSTIC BERMS.

PHASE D NOTES

ANGELA CRES.

BIRCHLAWN AVE.

- PREPARE SITE WITHIN AREA 3 BY REMOVING ALL EXISTING TREES AND SCRUB VEGETATION LOCATED IN THE AREA TO BE EXTRACTED.
- 3. BEGIN STRIPPING TOPSOIL AND OVERBURDEN SEPARATELY FROM AREA 3 AND USE TO CONSTRUCT ACOUSTIC BERM C (EXTENSION OF BERM B). INSTALL SILT FENCE AS SHOWN (SEE AIR QUALITY TECHNICAL RECOMMENDATIONS, THIS PAGE).
- 4. BEGIN EXTRACTION IN AREA 3, IN DIRECTION SHOWN.

TECHNICAL RECOMMENDATIONS

THE FOLLOWING ARE THE TECHNICAL RECOMMENDATIONS FROM ALL OF THE EXPERTS' REPORTS AS OF APRIL 2021, ADDITIONAL RECOMMENDATIONS MAY BE INCLUDED AS A RESULT OF THE PRE-LICENCE

ARCHAEOLOGICAL ASSESSMENT - GOLDER ASSOCIATES - SEPTEMBER 2017
SHOULD DEEPLY BURIED ARCHAEOLOGICAL RESOURCES BE IDENTIFIED DURING GROUND DISTURBANCE ACTIVITY ASSOCIATED WITH FUTURE DEVELOPMENT OF THE SITE, GROUND DISTURBANCE ACTIVITIES SHOULD BE IMMEDIATELY HALTED AND THE ARCHAEOLOGY DIVISION OF THE CULTURE PROGRAMS UNIT OF

SHOULD PREVIOUSLY UNDOCUMENTED ARCHAEOLOGICAL RESOURCES BE DISCOVERED, THEY MAY BE A NEW ARCHAEOLOGICAL SITE AND THEREFORE SUBJECT TO SECTION 48 (1) OF THE ONTARIO HERITAGE ACT. THE PROPONENT OR PERSON DISCOVERING THE ARCHAEOLOGICAL RESOURCES MUST CEASE ALTERATION OF THE SITE IMMEDIATELY AND ENGAGE A LICENSED CONSULTANT ARCHAEOLOGIST TO CARRY OUT ARCHAEOLOGICAL FIELDWORK, IN COMPLIANCE WITH SECTION 48(1) OF THE ONTARIO

THE FUNERAL, BURIAL AND CREMATION SERVICES ACT, 2002, S.O. 2002, C.33, REQUIRES THAT ANY PERSON DISCOVERING OR HAVING KNOWLEDGE OF A BURIAL SITE SHALL IMMEDIATELY NOTIFY THE POLICE OR CORONER. IT IS RECOMMENDED THAT THE REGISTRAR OF CEMETERIES AT THE MINISTRY OF CONSUMER SERVICES IS ALSO IMMEDIATELY NOTIFIED.

WATER RESOURCES ASSESSMENT - GOLDER ASSOCIATES - APRIL 2021

- 1. QUARTERLY GROUNDWATER LEVEL MONITORING SHALL BE CARRIED OUT ON MONITORING WELLS BH16-1, BH16-2, AND BH16-3 TO MONITOR GROUNDWATER FLUCTUATIONS AND CONFIRM THE HIGH GROUNDWATER TABLE IN ORDER TO ENSURE MAXIMUM DEPTH OF EXTRACTION IS AT LEAST 1.5m ABOVE THE WATER TABLE ON THE PROPERTY IN ACCORDANCE WITH THE WATER RESOURCE ASSESSMENT REPORT (GOLDER, 2020),
- 2. ANNUAL WATER QUALITY MONITORING SHALL TAKE PLACE IN MONITORING WELLS BH16-1, BH16-2 AND BH16-3 DURING OPERATIONS, AND UP TO THE POINT OF LICENCE SURRENDER, FOR THE FOLLOWING PARAMETERS: GENERAL INORGANICS, METALS AND BENZENE, TOLUENE, ETHYLBENZENE AND XYLENE
- 3. WATER LEVEL AND QUALITY MONITORING SHALL BE DOCUMENTED IN AN ANNUAL REPORT BY A QUALIFIED PROFESSIONAL AND PROVIDED TO THE LICENSEE BY APRIL 30 AND BE AVAILABLE FOR REVIEW UPON REQUEST SHOULD NDMNRF REQUEST IT.

NOISE IMPACT ASSESSMENT - GOLDER ASSOCIATES - MARCH 2021

- 1. THE IDENTIFIED BERMS WILL BE INSTALLED PRIOR TO EXTRACTION IN AREAS 1, 2, AND 3:
- a) BERM A SHALL BE INSTALLED ALONG THE SOUTH BORDER OF AREA 1 AND ALONG THE EAST BORDER OF AREA 1 AND 2, WITH A MINIMUM HEIGHT OF 5m ABOVE EXISTING GRADE, PRIOR TO EXTRACTION IN
- b) BERM B SHALL BE INSTALLED ALONG THE EAST BORDER OF AREAS 2 AND PARTIALLY AREA 3, WITH A MINIMUM HEIGHT OF 5m ABOVE EXISTING GRADE, PRIOR TO EXTRACTION IN AREA 2. THIS IS AN EXTENSION OF BERM A.
- c) BERM C SHALL BE INSTALLED ALONG THE EAST BORDER OF AREA 3 WITH A MINIMUM HEIGHT OF 5m ABOVE EXISTING GRADE, PRIOR TO EXTRACTION AREA 3, THIS IS AN EXTENSION OF BERM B.
- d) BERM D WILL BE INSTALLED ALONG THE NORTH BORDER OF NORTH LIMIT OF EXTRACTION WITH A MINIMUM HEIGHT OF 3m ABOVE EXISTING GRADE, PRIOR TO EXTRACTION IN AREA 3.
- 2. ONCE INSTALLED, BARRIERS SHALL REMAIN THROUGHOUT THE COMPLETION OF EXTRACTION OF THE EXTENSION LANDS. 3. LOCAL BARRIERS, OR ACOUSTICALLY EQUIVALENT SOURCE TREATMENT REDUCING NOISE LEVELS OF THE CRUSHING/SCREENING PLANT TO 55 dBA WHEN MEASURED AT A DISTANCE OF 100 m (IN THE
- DIRECTION OF PORS) SHALL BE INSTALLED. 4. ALTERNATIVE EQUIPMENT/OPERATIONS CAN BE CONSIDERED IF ASSESSED BY AN ACOUSTICAL CONSULTANT AND SHOWN TO MEET THE APPLICABLE NOISE LIMITS.

NATURAL ENVIRONMENT REPORT - GOLDER ASSOCIATES - APRIL 2021

- 1. GROUNDWATER LEVEL MONITORING, AS DESCRIBED IN THE MAXIMUM PREDICTED WATER TABLE REPORT (GOLDER 2021), WILL BE IMPLEMENTED; AND
- 2. THE SITE WILL BE REHABILITATED IN ACCORDANCE WITH THE REQUIREMENTS OF THE REHABILITATION PLAN RETURNING THE SITE PRIMARILY TO AGRICULTURAL USE.

AIR QUALITY IMPACT ASSESSMENT - GOLDER ASSOCIATES - DECEMBER 2019

- 1. NO PROCESSING EQUIPMENT SHALL BE LOCATED ON THE EXPANSION LAND AND/OR NO STOCKPILING OF EXTRACTED MATERIALS.
- 2. WATER, OR SIMILAR DUST SUPPRESSANT WILL BE APPLIED TO ROADS IN THE EXPAMSION AREA ON OPERATIONAL DAYS, AFTER 24-HOUR PERIODS OF NO PRECIPITATION.
- 3. A SILT FENCE WILL BE INSTALLED AT THE TOE OF THE BERM TO BE INSTALLED IN THE EXPANSION
- 4. A SPEED LIMIT OF 25 km PER HOUR WILL BE IMPOSED ON ROADS IN THE EXPANSION AREA.

LEGEND

EXISTING VEGETATION

BOUNDARY OF AREA TO BE LICENSED BOUNDARY OF EXISTING LICENCE

LIMIT OF EXTRACTION LINE

REGULATORY SETBACK LINE

120m INFORMATION BOUNDARY

EXISTING BUILDING HP EXISTING HYDRO POLE

DIRECTION OF TOPSOIL AND OVERBURDEN MOVEMENT

DIRECTION OF EXTRACTION AREA STRIPPED OF TOPSOIL

EXISTING ENTRANCE/ EXIT

AREA UNDER REHABILITATION REHABILITATION COMPLETE

EXISTING WETLAND


UNDISTURBED AREA

AND OVERBURDEN

EXTRACTION FACE

BERM (MIN. HEIGHT AS SHOWN)

PRODUCT TRANSPORTATION

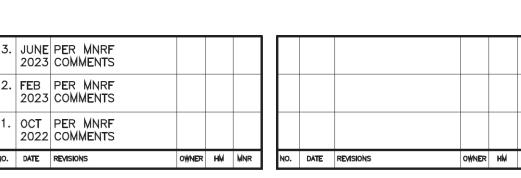

Site Plan Amendments Pre Licence Review



Project Name



St. Marys Cement Inc. (Canada) 55 Industrial Street **Toronto, Ontario** M4G 3W9 (416) 423-1300

DANCE PIT EXTENSION

LICENSEE SIGNATURE LICENCE No. PART LOT 14 &15, CONCESSION 10 TOWNSHIP OF NORTH DUMFRIES, REGIONAL MUNICIPALITY OF WATERLOO

Scale 1:4000 **Drawing Status ISSUED** FOR APPROVAL

Drawn A.C./S.B.

Drawing Title


Checked G.D.H./R.M.


Project Number

Drawing Number

OPERATIONAL PLAN PHASE B - D

Issue Date JUNE 2023 12-10

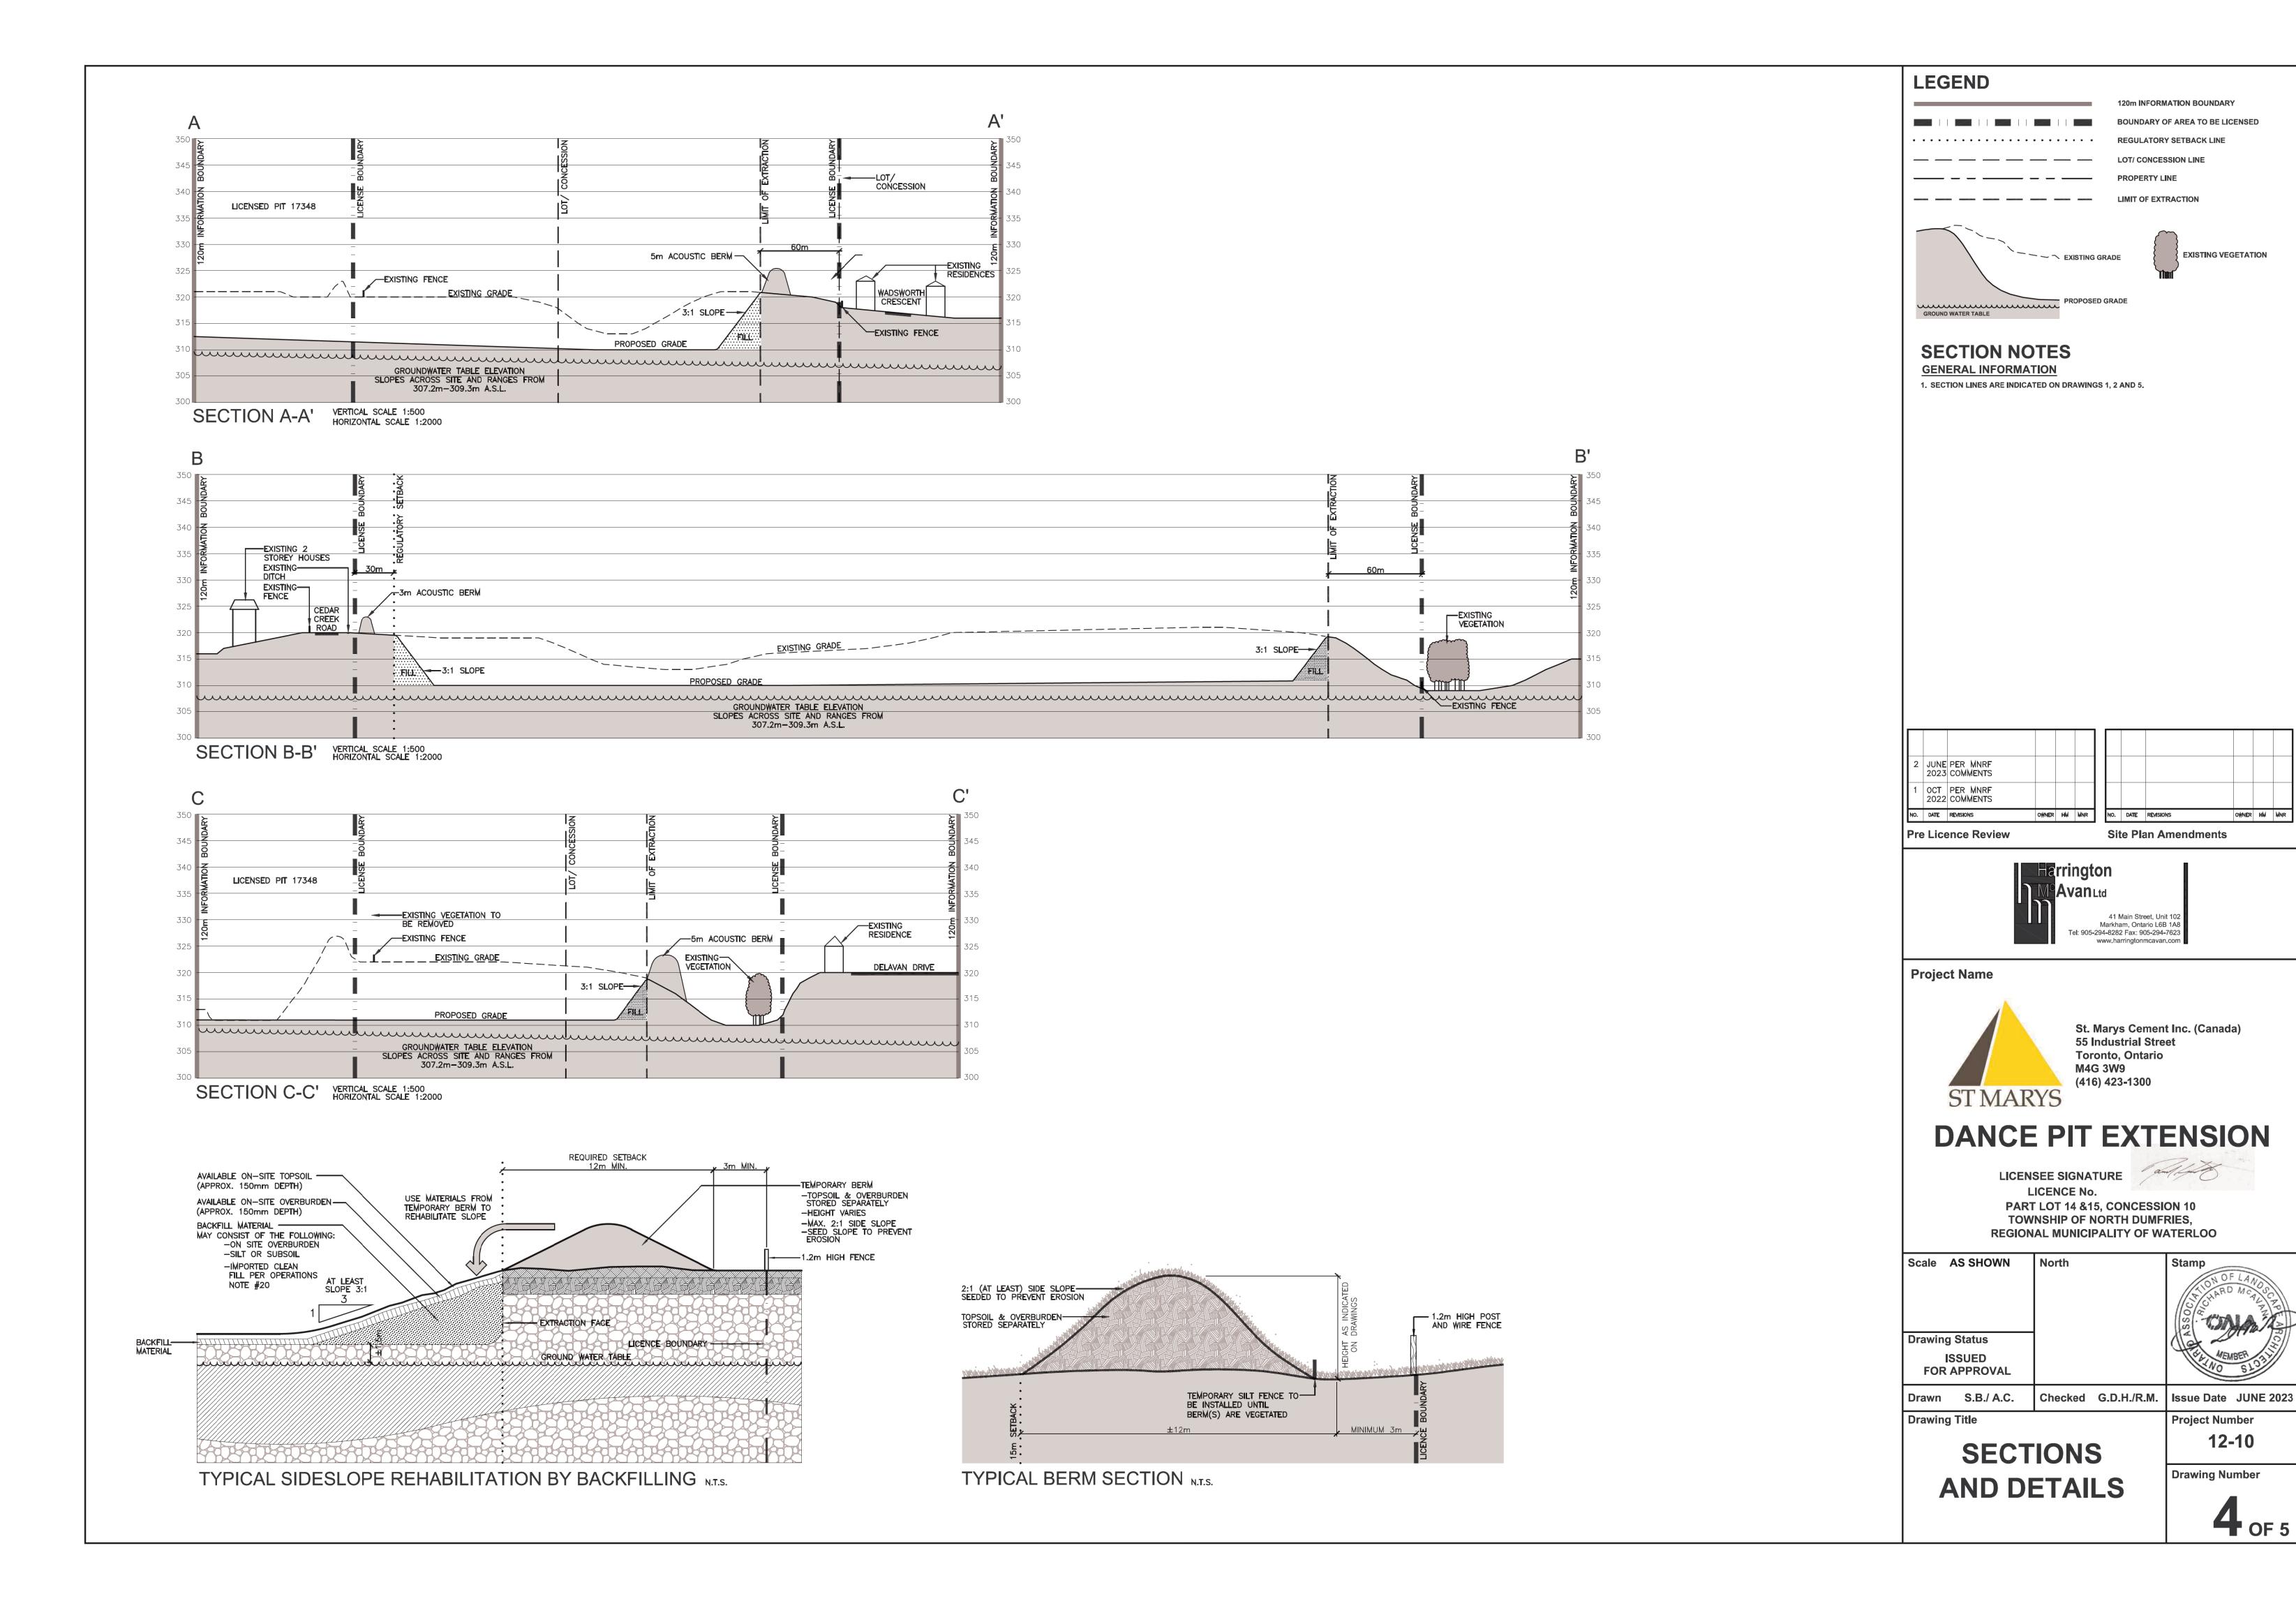

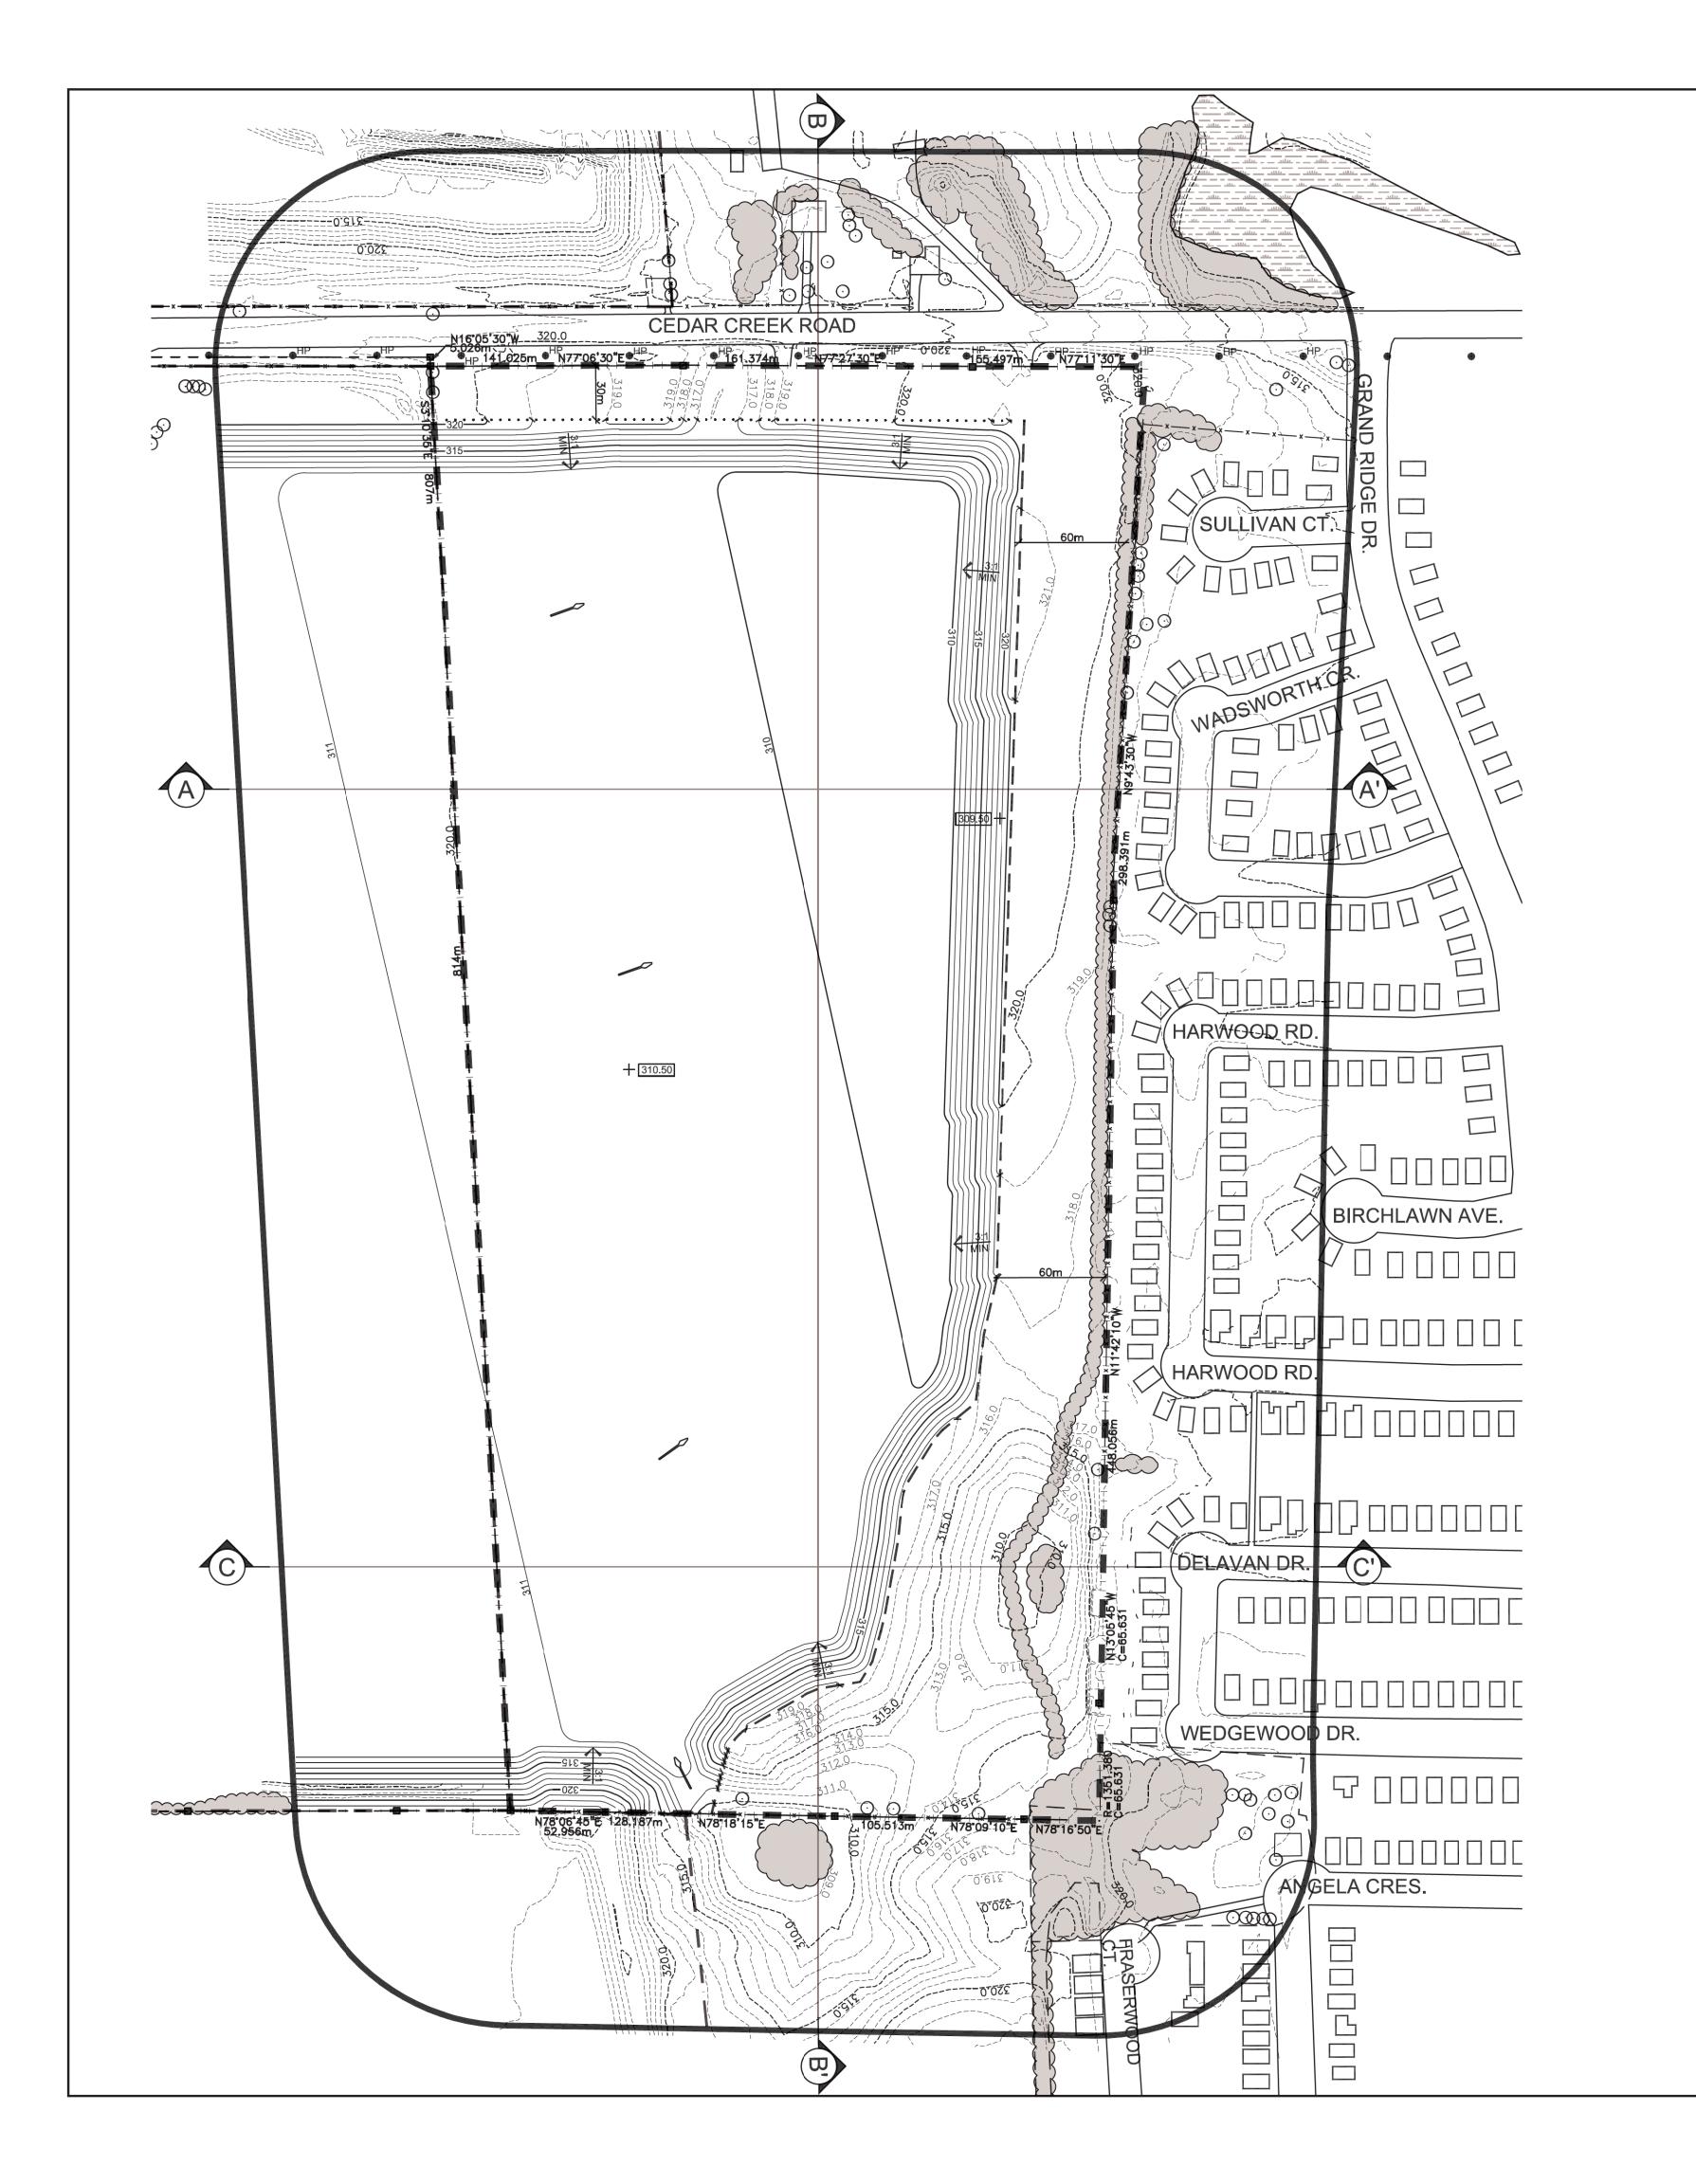

REHABILITATION NOTES

GENERAL INFORMATION

1. REFER TO SHEET 4 OF 5 FOR SECTIONS, SHEETS 2 & 3 OF 5 FOR OPERATIONS AND PHASING DIAGRAMS AND NOTES AND SHEET 5 OF 5 FOR FINAL REHABILITATION AND NOTES.

2. THE PROPERTY SHALL BE REHABILITATED TO AGRICULTURE, AS IT WAS PRIOR TO LICENSING:

TOTAL REHABILITATION

HYDROGEOLOGICAL INFORMATION

3. THE GROUNDWATER ELEVATION SLOPES ACROSS THE SITE AND WILL REMAIN RELATIVELY UNCHANGED AT 307.2 - 309.3m MASL (REFER TO WATER RESOURCE ASSESSMENT REPORT BY GOLDER ASSOCIATES LTD., DATED APRIL 2021).

4. ALL SURFACE DRAINAGE WILL BE DIRECTED TO THE LOW AREAS REMAINING ON THE PIT

FLOOR SO THAT THE WATER CAN INFILTRATE INTO THE SOILS.

SIDESLOPE/MEADOW REHABILITATION INFORMATION

5. REHABILITATED SLOPES WITHIN THE LICENCED AREA WILL BE CONSTRUCTED AS SHOWN ON THE CROSS SECTIONS. SLOPES SHALL BE REHABILITATED BY BACKFILLING (MINIMUM 3:1) AND/OR CUT AND FILL METHOD USING AVAILABLE ON-SITE OVERBURDEN AND TOPSOIL AND/OR CLEAN INERT IMPORTED FILL PER OPERATIONAL NOTE 20, PAGE 2. SIDESLOPES MAY BE FLATTENED TO INCREASE AGRICULTURAL VIABILITY. GRADES WILL MATCH ADJACENT LICENCE

REFER TO DRAWING 4 OF 5, SECTIONS AND DETAILS, FOR MORE INFORMATION ON BACKFILLING AND CREATION OF REHABILITATED SIDESLOPES.

TALL FESCUE

TOPSOILING INFORMATION

6. ALL AVAILABLE TOPSOIL ON THE SITE WILL REMAIN TO BE USED FOR REHABILITATION OF THIS SITE. PRE-EXTRACTION TOPSOIL DEPTHS ACROSS THE SITE ARE VARIABLE, RANGING FROM 150MM - 500MM. DURING REHABILITATION STORED TOPSOIL WILL BE PLACED TO A DEPTH OF 200MM - 400MM ACROSS THE SITE.

VEGETATION STABILIZATION INFORMATION

7. TOPSOIL SHALL BE SEEDED WITH A MIXTURE OF GRASSES AND LEGUMES THAT MAY INCLUDE THE FOLLOWING AT A RATE OF APPROXIMATELY 125 kg/HA: BUCKWHEAT RED CLOVER WHITE CLOVER

REHABILITATING TO AGRICULTURAL FIELDS INFORMATION

8. AREAS SHALL BE REHABILITATED BACK TO AGRICULTURE AS FOLLOWS: - DEEP RIPPING OF AREA TO ELIMINATE COMPACTION (WHERE REQUIRED) - SPREADING OF APPROXIMATELY 200mm OF OVERBURDEN AND ROUGH GRADING - STONE PICKING OF STONES GREATER THAN 75mm AS REQUIRED

- SPREADING OF APPROXIMATELY 200-400mm OF TOPSOIL AND FINE GRADING

ANNUAL RYE

- SEED AREAS WITH SEED MIXTURE NOTED ABOVE. - ALL VEGETATION PLANTED DURING THIS LICENSE WILL BE MAINTAINED IN A HEALTHY, VIGOROUS GROWING CONDITION.
- USE OF ACCEPTED FARMING PRACTICES (MANURE/FERTILIZER APPLICATIONS) TO RESTORE AND MAINTAIN VEGETATION.

- IN SUPPORT OF FINAL REHABILITATION, SOIL SAMPLING WILL BE UNDERTAKEN TO ASSESS POST-EXTRACTION SOIL CHARACTERISTICS (E.G., MACRO AND MICRONUTRIENTS, PH, CEC, ORGANIC MATTER, SOIL TEXTURE, STRUCTURE, AND BULK DENSITY ETC.), RELATIVE TO THE DOCUMENTED BASELINE SOIL CHARACTERISTICS, USING AN ACCREDITED LAB FOR ANALYTICAL TESTING. ADJUSTMENTS TO CROPPING PRACTISES AND/OR SOIL AMENDMENTS MAY BE REQUIRED BASED ON THE RESULTS OF THE SOIL TESTING, IN CONSULTATION WITH THE TENANT FARMER, TO ENSURE SUBSTANTIALLY THE SAME AVERAGE SOIL CAPABILITY FOR AGRICULTURE THAT EXISTED PRE-EXTRACTION IS RESTORED.

FINAL REHABILITATION INFORMATION

9. UPON COMPLETION OF EXTRACTION, ALL SCRAP AND EQUIPMENT SHALL BE REMOVED FROM THE SITE. ALL INTERNAL HAUL ROADS SHALL BE REHABILITATED ONCE NO LONGER IN USE FOR EXTRACTION RELATED ACTIVITIES.

IMPORTATION OF EXCESS SOIL

10a) EXCESS SOIL, AS DEFINED IN ONTARIO REGULATION 244/97 UNDER THE ENVIRONMENTAL PROTECTION ACT, MAY BE IMPORTED TO THIS SITE TO FACILITATE THE FOLLOWING

I. CREATION OF 3:1 SLOPES (OR SLOPING RATIO OTHERWISE DESCRIBED FOR FINAL REHABILITATION II. TOP DRESSING TO ESTABLISH VEGETATION

b) LIQUID SOIL, AS DEFINED IN ONTARIO REGULATION 406/19 UNDER THE ENVIRONMENTAL PROTECTION ACT, IS NOT AUTHORIZED FOR IMPORTATION TO THE SITE.

c) THE QUALITY OF EXCESS SQUI IMPORTED TO THE SITE FOR FINAL PLACEMENT MUST BE EQUIVALENT TO OR MORE STRINGENT THAN THE APPLICABLE EXCESS SOIL QUALITY STANDARDS AS DETERMINED IN ACCORDANCE WITH ONTARIO REGULATION 244/97 AS AMENDED FROM TIME TO TIME AND MUST BE CONSISTENT WITH THE SITE CONDITIONS AND THE END USE IDENTIFIED IN THE APPROVED REHABILITATION PLAN.

d) WHERE A QUALIFIED PERSON IS RETAINED OR REQUIRED TO BE RETAINED IN ACCORDANCE WITH ONTARIO REGULATION 244/97, THE QUALITY, STORAGE, AND FINAL PLACEMENT OF EXCESS SOILS SHALL BE DONE ACCORDING TO THE ADVICE OF THE QUALIFIED PERSON.

e) EXCESS SOIL IMPORTED TO FACILITATE REHABILITATION AS DESCRIBED ON THIS SITE PLAN SHALL BE UNDERTAKEN IN ACCORDANCE WITH ONTARIO REGULATION 244/97 UNDER THE AGGREGATE RESOURCES ACT, AS AMENDED FROM TIME TO TIME.

f) THE CUMULATIVE TOTAL AMOUNT OF EXCESS SOIL THAT MAY BE IMPORTED TO THIS SITE FOR REHABILITATION PURPOSES IS 250,000 M3.

LEGEND

120m INFORMATION BOUNDARY BOUNDARY OF AREA TO BE LICENSED **BOUNDARY OF AREA TO BE LICENSED** PROPERTY LINE

EXISTING WETLAND

EXISTING HYDRO POLE

REGULATORY SETBACK LINE LOT/ CONCESSION LINE

LIMIT OF EXTRACTION EXISTING VEGETATION

= $\frac{311}{}$ = EXISTING 1m CONTOUR LINE PROPOSED 1m CONTOUR LINE PROPOSED 1m CONTOUR LINE DIRECTION OF SURFACE WATER DRAINAGE

___ <u>310</u> __ EXISTING 1m CONTOUR LINE

EXISTING BUILDING

DIRECTION OF SURFACE WATER DRAINAGE

5 JULY PER OMAFRA 2023 COMMENTS 4 JUNE PER OMAFRA 2023 COMMENTS 3 JUNE PER OMAFRA & 2023 MNRF COMMENTS 2 FEB PER MNRF 2023 COMMENTS OCT PER MNRF 2022 COMMENTS IO. DATE REVISIONS

NO. DATE REVISIONS

Pre Licence Review

Site Plan Amendments



Project Name



St. Marys Cement Inc. (Canada) 55 Industrial Street Toronto, Ontario M4G 3W9 (416) 423-1300


DANCE PIT EXTENSION


LICENSEE SIGNATURE LICENCE No. PART LOT 14 &15, CONCESSION 10 TOWNSHIP OF NORTH DUMFRIES, REGIONAL MUNICIPALITY OF WATERLOO

Scale 1:2000 **Drawing Status ISSUED**

FOR APPROVAL

Drawing Title

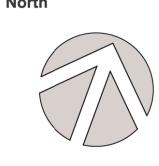

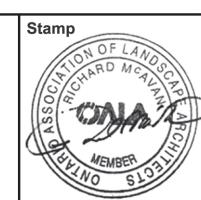

Checked G.D.H./R.M. Drawn A.C./S.B.

Issue Date JULY 2023 **Project Number**

Drawing Number

REHABILITATION PLAN

12-10